
APPENDIX B PROPOSAL MAPS AND DRAWINGS

- **B.1 ORIGINAL LAYOUT**
- **B.2** REVISED LAYOUT (TAKING INTO ACCOUNT CONSTRAINTS)



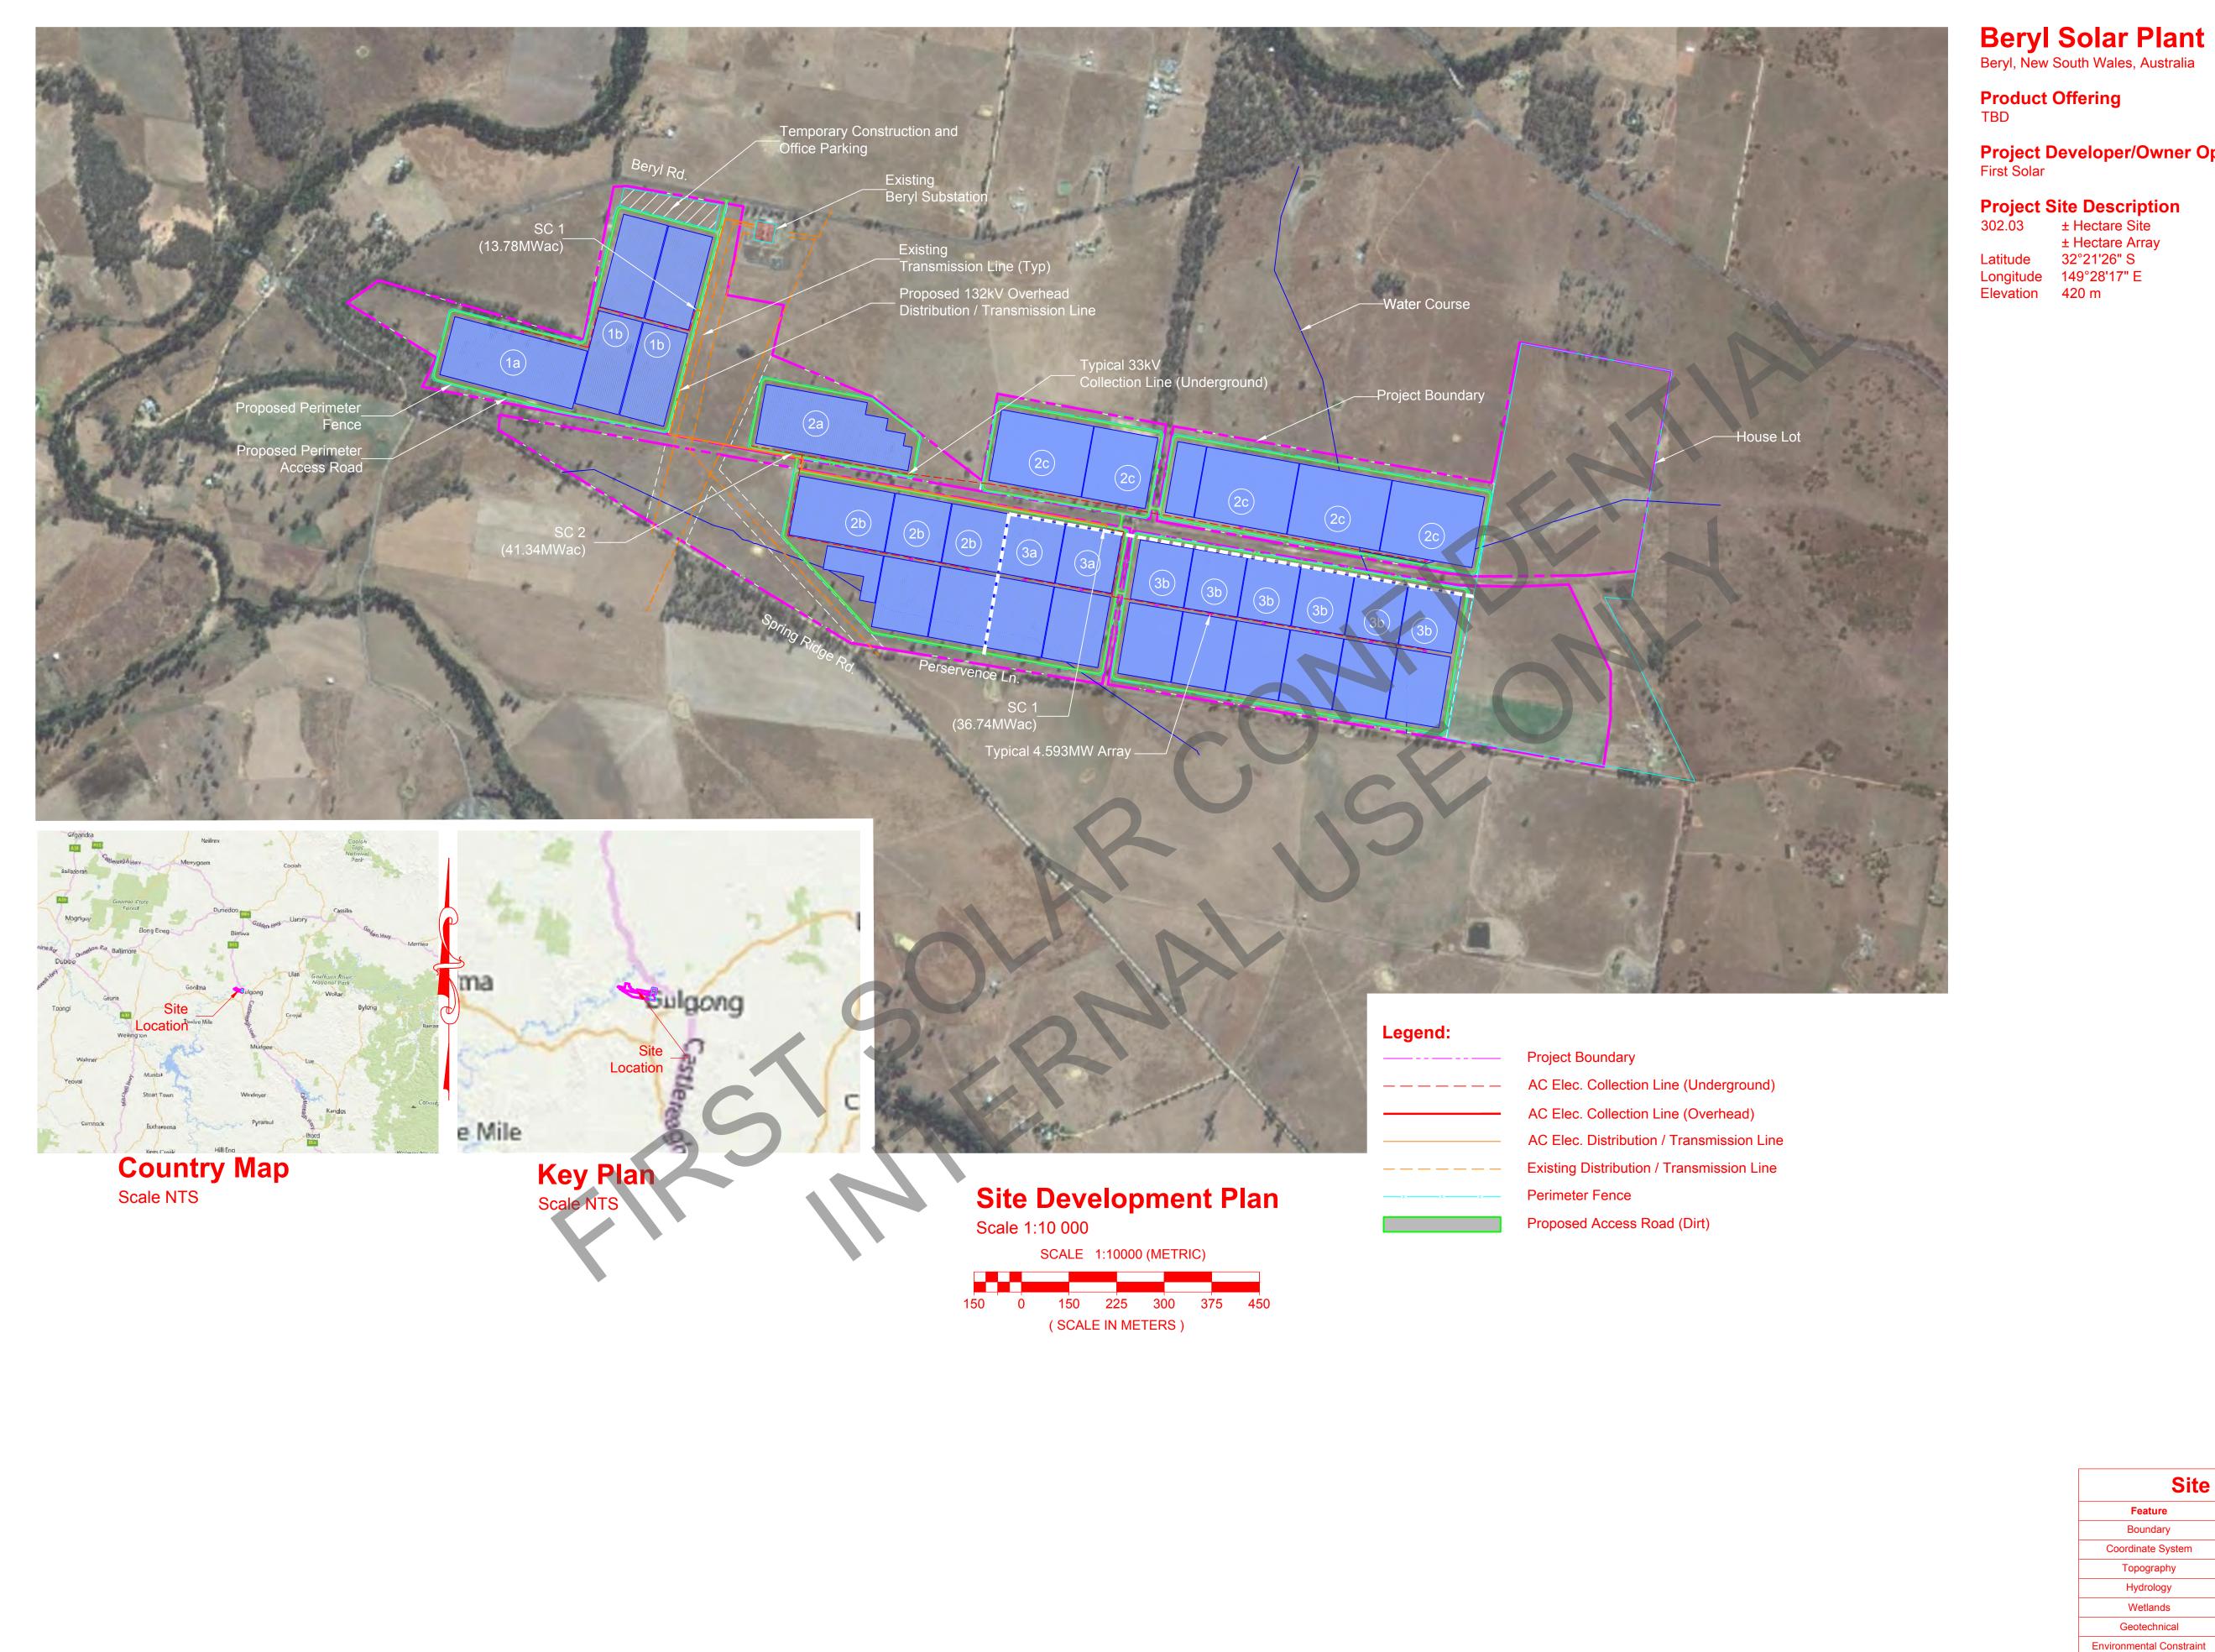

Project Developer/Owner Operator

Project Site Description

First Solar®
FIRST SOLAR, LLC
400 CROSSING BOULEVARD. 5TH FLOOR
BRIDGEWATER, NJ 08807 PHONE: (908) 809-4000 WWW.FIRSTSOLAR.COM

FS JOB #: 0000-0000-00 PROJ. DSGR: Daiva Kinneman PROJ. ENGR: PROJ. MGR: PROJ. DIR: John Hartelius P.E. Map Grid of Australia Zone 55, using GDA94 datum SCALE: AS NOTED SHEET TITLE Site Development SD-100-T

SHEET 1 OF 1

Site Plan Data Source

THIS PRINT IS DESIGNED FOR 24" X 36" PLOTTING

THIS SITE DEVELOPMENT PLAN IS PRELIMINARY AND SUBJECT TO REVISION BASED ON, AMONG OTHER THINGS, CHANGES IN PROJECT

SCHEDULE, TECHNOLOGY, AND/OR SITE SPECIFIC CONSTRAINTS.

THIS PRINT IS NOT TO BE USED FOR CONSTRUCTION UNLESS NOTED AND SIGNED OK FOR CONSTRUCTION ABOVE LAST REVISION.

Feature

Boundary


Coordinate System

Topography Hydrology

Wetlands Geotechnical Description

Beryl PV Site KMZ

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Beryl Solar Plant Beryl, New South Wales, Australia

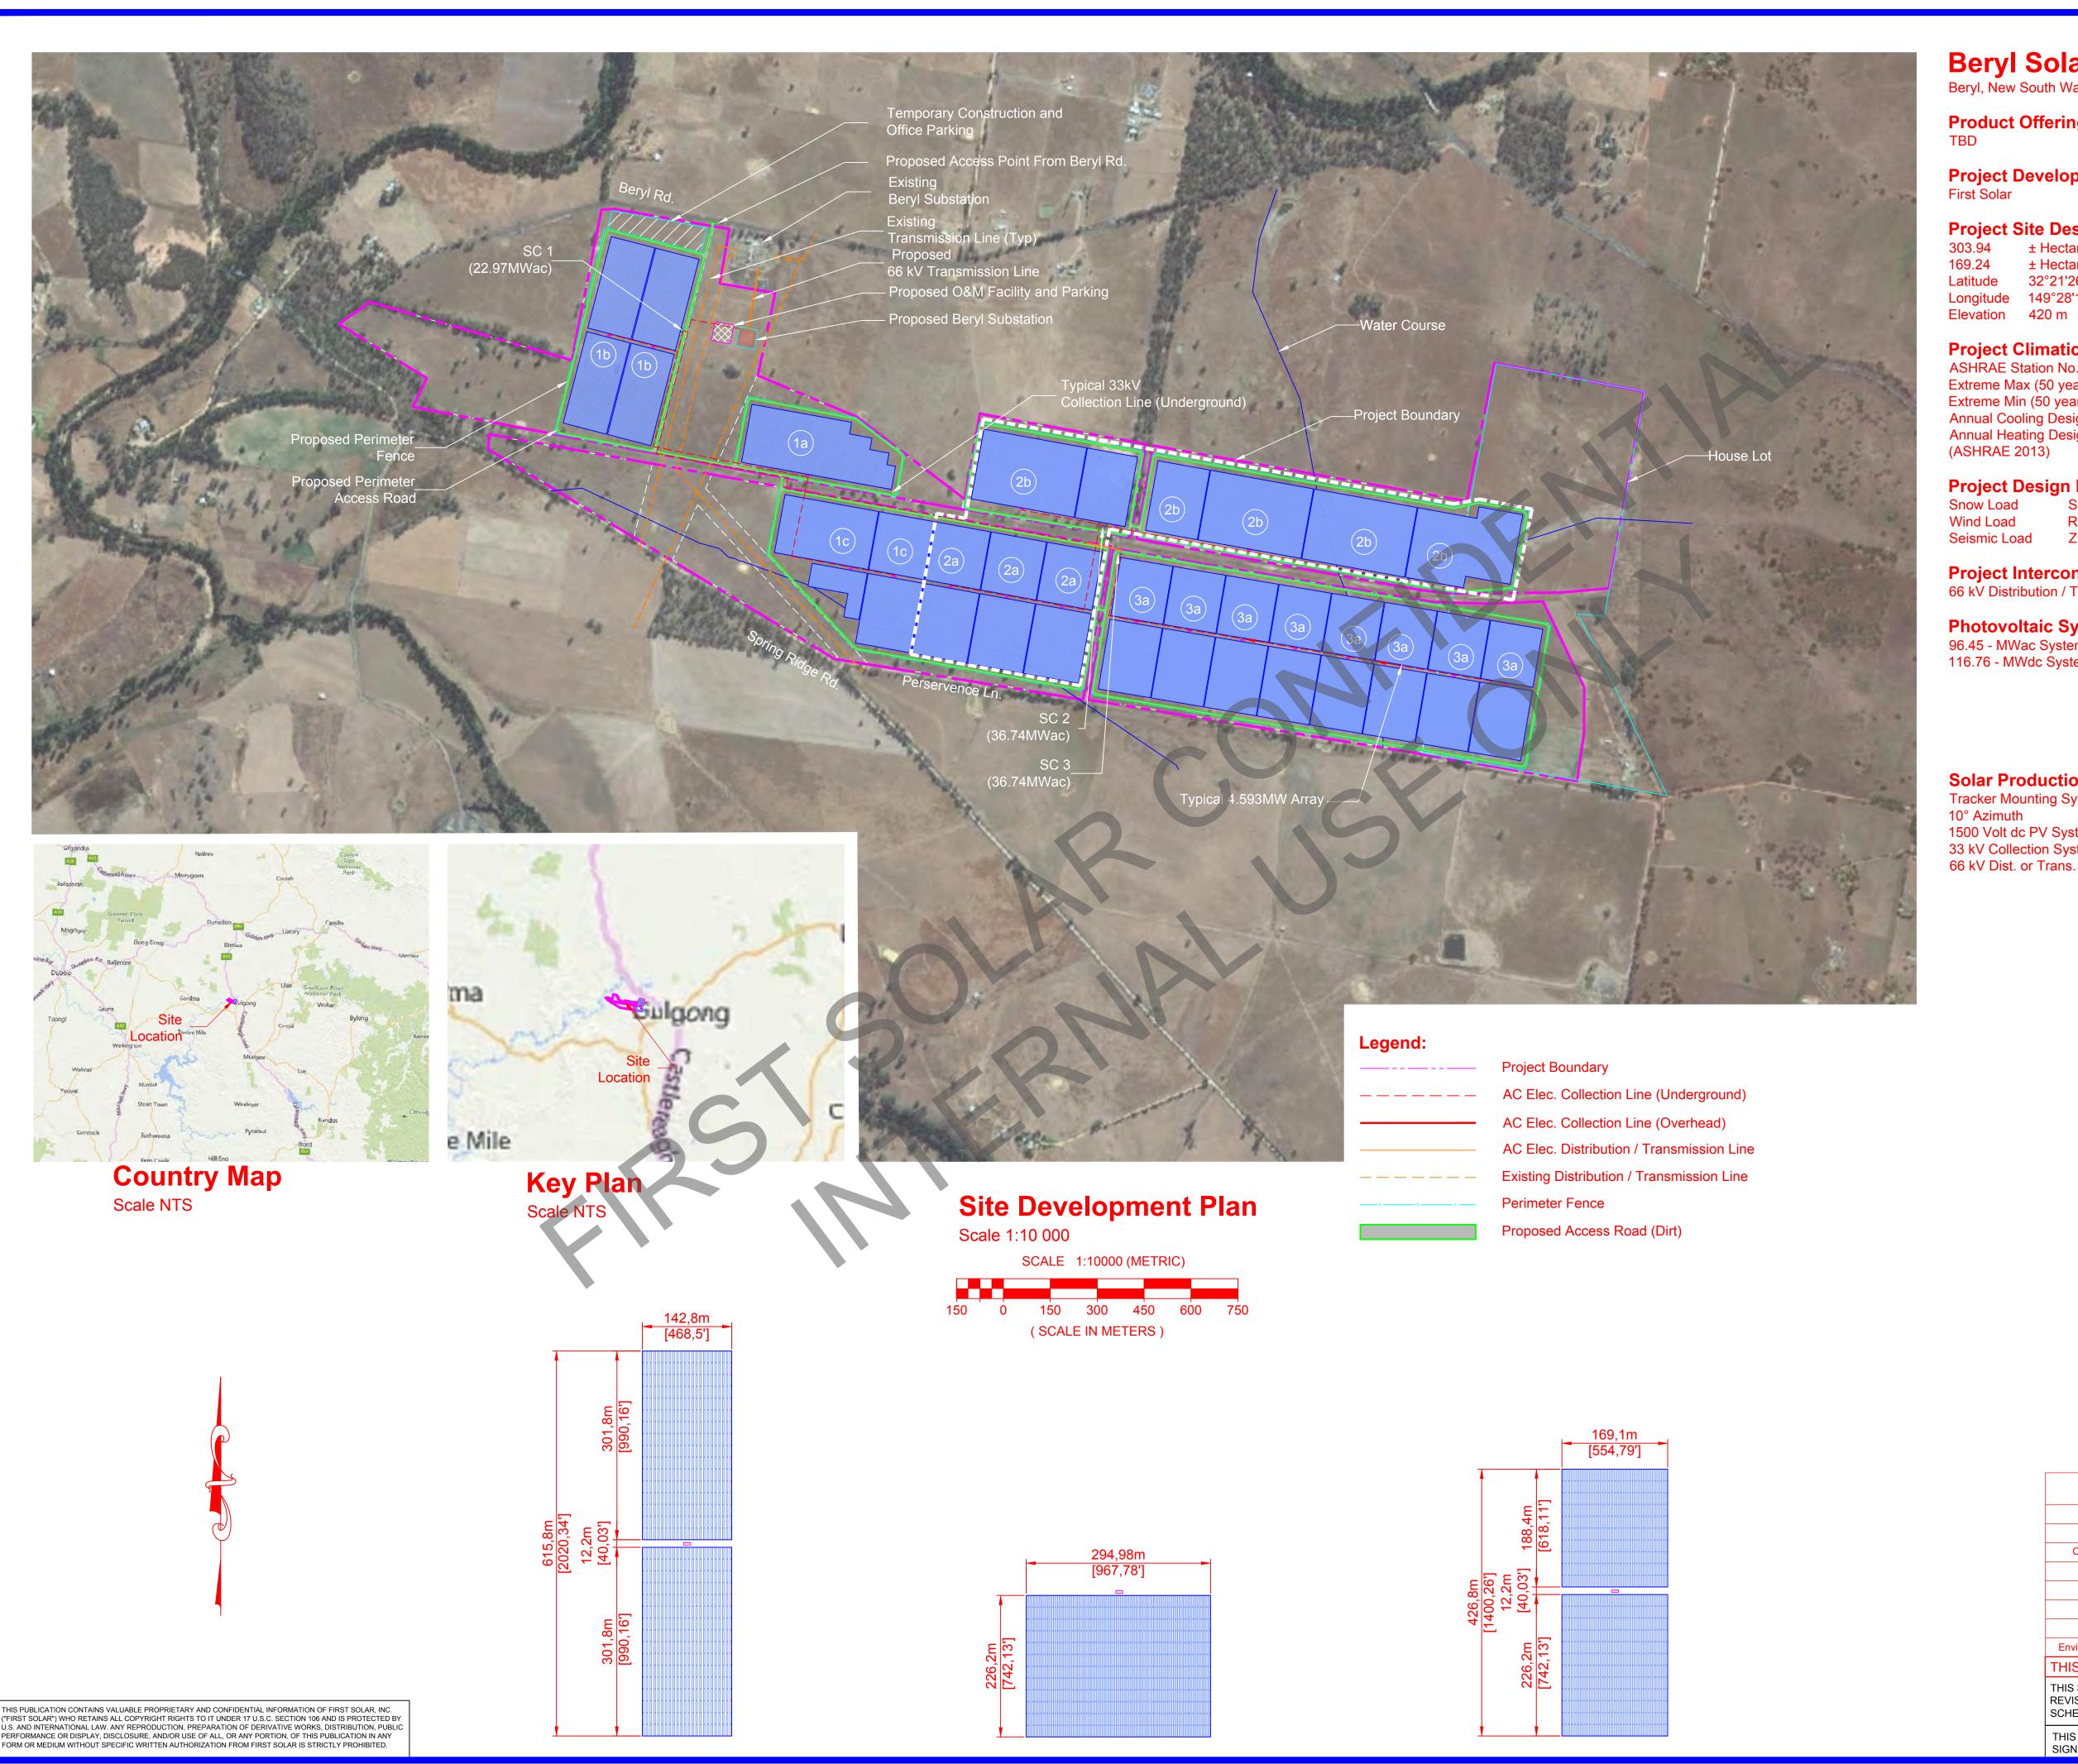Product Offering

Project Developer/Owner Operator

Project Site Description

303.94 ± Hectare Site ± Hectare Array 32°21'26" S Longitude 149°28'17" E

Project Climatic Conditions

ASHRAE Station No. 947270 Extreme Max (50 year) Temp 43.1 °C -7.7 °C Extreme Min (50 year) Temp Annual Cooling Design Temp Annual Heating Design Temp (ASHRAE 2013) 34.7 °C -2.7 °C

Project Design Data

Wind Load Region A1, Vr=43m/s Seismic Load Z=0.08, Kp=0.75

Project Interconnection

66 kV Distribution / Transmission Line to Existing Beryl Substation

Photovoltaic System Parameters

96.45 - MWac System Capacity (Nominal Output) 116.76 - MWdc System Capacity (Nominal Output)

Solar Production

Tracker Mounting System 1500 Volt dc PV System Design 33 kV Collection System 66 kV Dist. or Trans. System

Array	Types	Qty
Standard	3	17
Sub-Array	1	1
Custom	3	3

Site Plan Data Source

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SCHEDULE, TECHNOLOGY, AND/OR SITE SPECIFIC CONSTRAINTS.

Feature

Boundary Coordinate System

Topography Hydrology Wetlands Geotechnical **Environmental Constraint** First Solar®
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400 CROSSING BOULEVARD. 5TH FLOOR
BRIDGEWATER, NJ 08807 PHONE: (908) 809-4000 WWW.FIRSTSOLAR.COM

	3-17-17	Revised Capacity	X	Ηſ	┐┐
()	2-20-17	Revised Per Comments	FD	Ηſ	∍
	11-10-16	Revised Array Layout	FD	Ης	⋾
	10-28-16	Conceptual Design - Tracker Mounting System	K	F)	⋾
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